

- PHASE 1 PRELIMINARY DESIGN BASED ON SURVEY, HISTORIC DRAWINGS, AERIAL IMAGERY, SITE INVESTIGATIONS, KPFF STRUCTURAL REPORT, AND HYDROLOGIC MODELS.

- ALL DIMENSIONS AND DESIGN ELEMENTS TO BE FIELD VERIFIED.

- KPFF STRUCTURAL COMMENT: YARD AREA - FILL BEHIND PIPECHASE SHOULD BE CONSIDERED FOR SEISMIC STABILIZATION. CONCERNS RELATE TO LATERAL LOADING ON PIPECHASE DURING A SEISMIC EVENT AND POTENTIAL SETTLING/LIQUIFICATION OF FILL MATERIALS.

1	INTERIM PARKING AREA	8	RECOVERY BOILER
2	PROJECT ENTRY	9	BOILER PLANT
3	MAIN STREET ENTRANCE	10	HIGH DENSITY STOCK CYLINDER
4	WOOLEN MILL	11	MILL H
5	CARPENTRY SHOP	12	PGE DAM
6	THE YARD		
7	PIPE CHASE		

- - - - - PROPERTY LINE
 - - - - - PHASE 1 BOUNDARY
 ————— INTERIM ACCESS AREA
 1996 FLOOD LINE
 OHWE (ORDINARY HIGH WATER ELEV.)
 OLWE (ORDINARY LOW WATER ELEV.)*
 *MAY OVERLAP WITH PROPERTY LINE



SCALE: 1" = 60' - 0"

ISSUED FOR		
1	PHASE I DRAWING SET	6/29/201

NOT FOR CONSTRUCTION

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CLIENT:



LEAD LANDSCAPE ARCHITECT:

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--	---

CLIENT CONSULTANTS:

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ENVIRONMENTAL ENGINEERING MAUL FOSTER ALONGI 2001 NW 15TH AVENUE, SUITE 200 PORTLAND, OR 97209	

SEAL

Willamette Falls
RIVERWALK PROJECT

PHASE 1
SITE PLAN

DRAWN: EG
PLOT DATE: 6/29/2018

L- 001

DRAWING NO:

SYMBOL LEGEND



- PROPERTY LINE
- INTERIM ACCESS AREA
- 1996 FLOOD LINE
- STRUCTURES TO BE REMOVED
- TRUCTURES FOR REUSE
- OHWE (ORDINARY HIGH WATER ELEV.)
- OLWE (ORDINARY LOW WATER ELEV.)*
- *MAY OVERLAP WITH PROPERTY LINE


PROGRAM LEGEND

- 1 TRUCK DUMP (RETAINED)
- 2 DE-INK
- 3 WOOLEN MILL FOUNDATION
- 4 MILL O





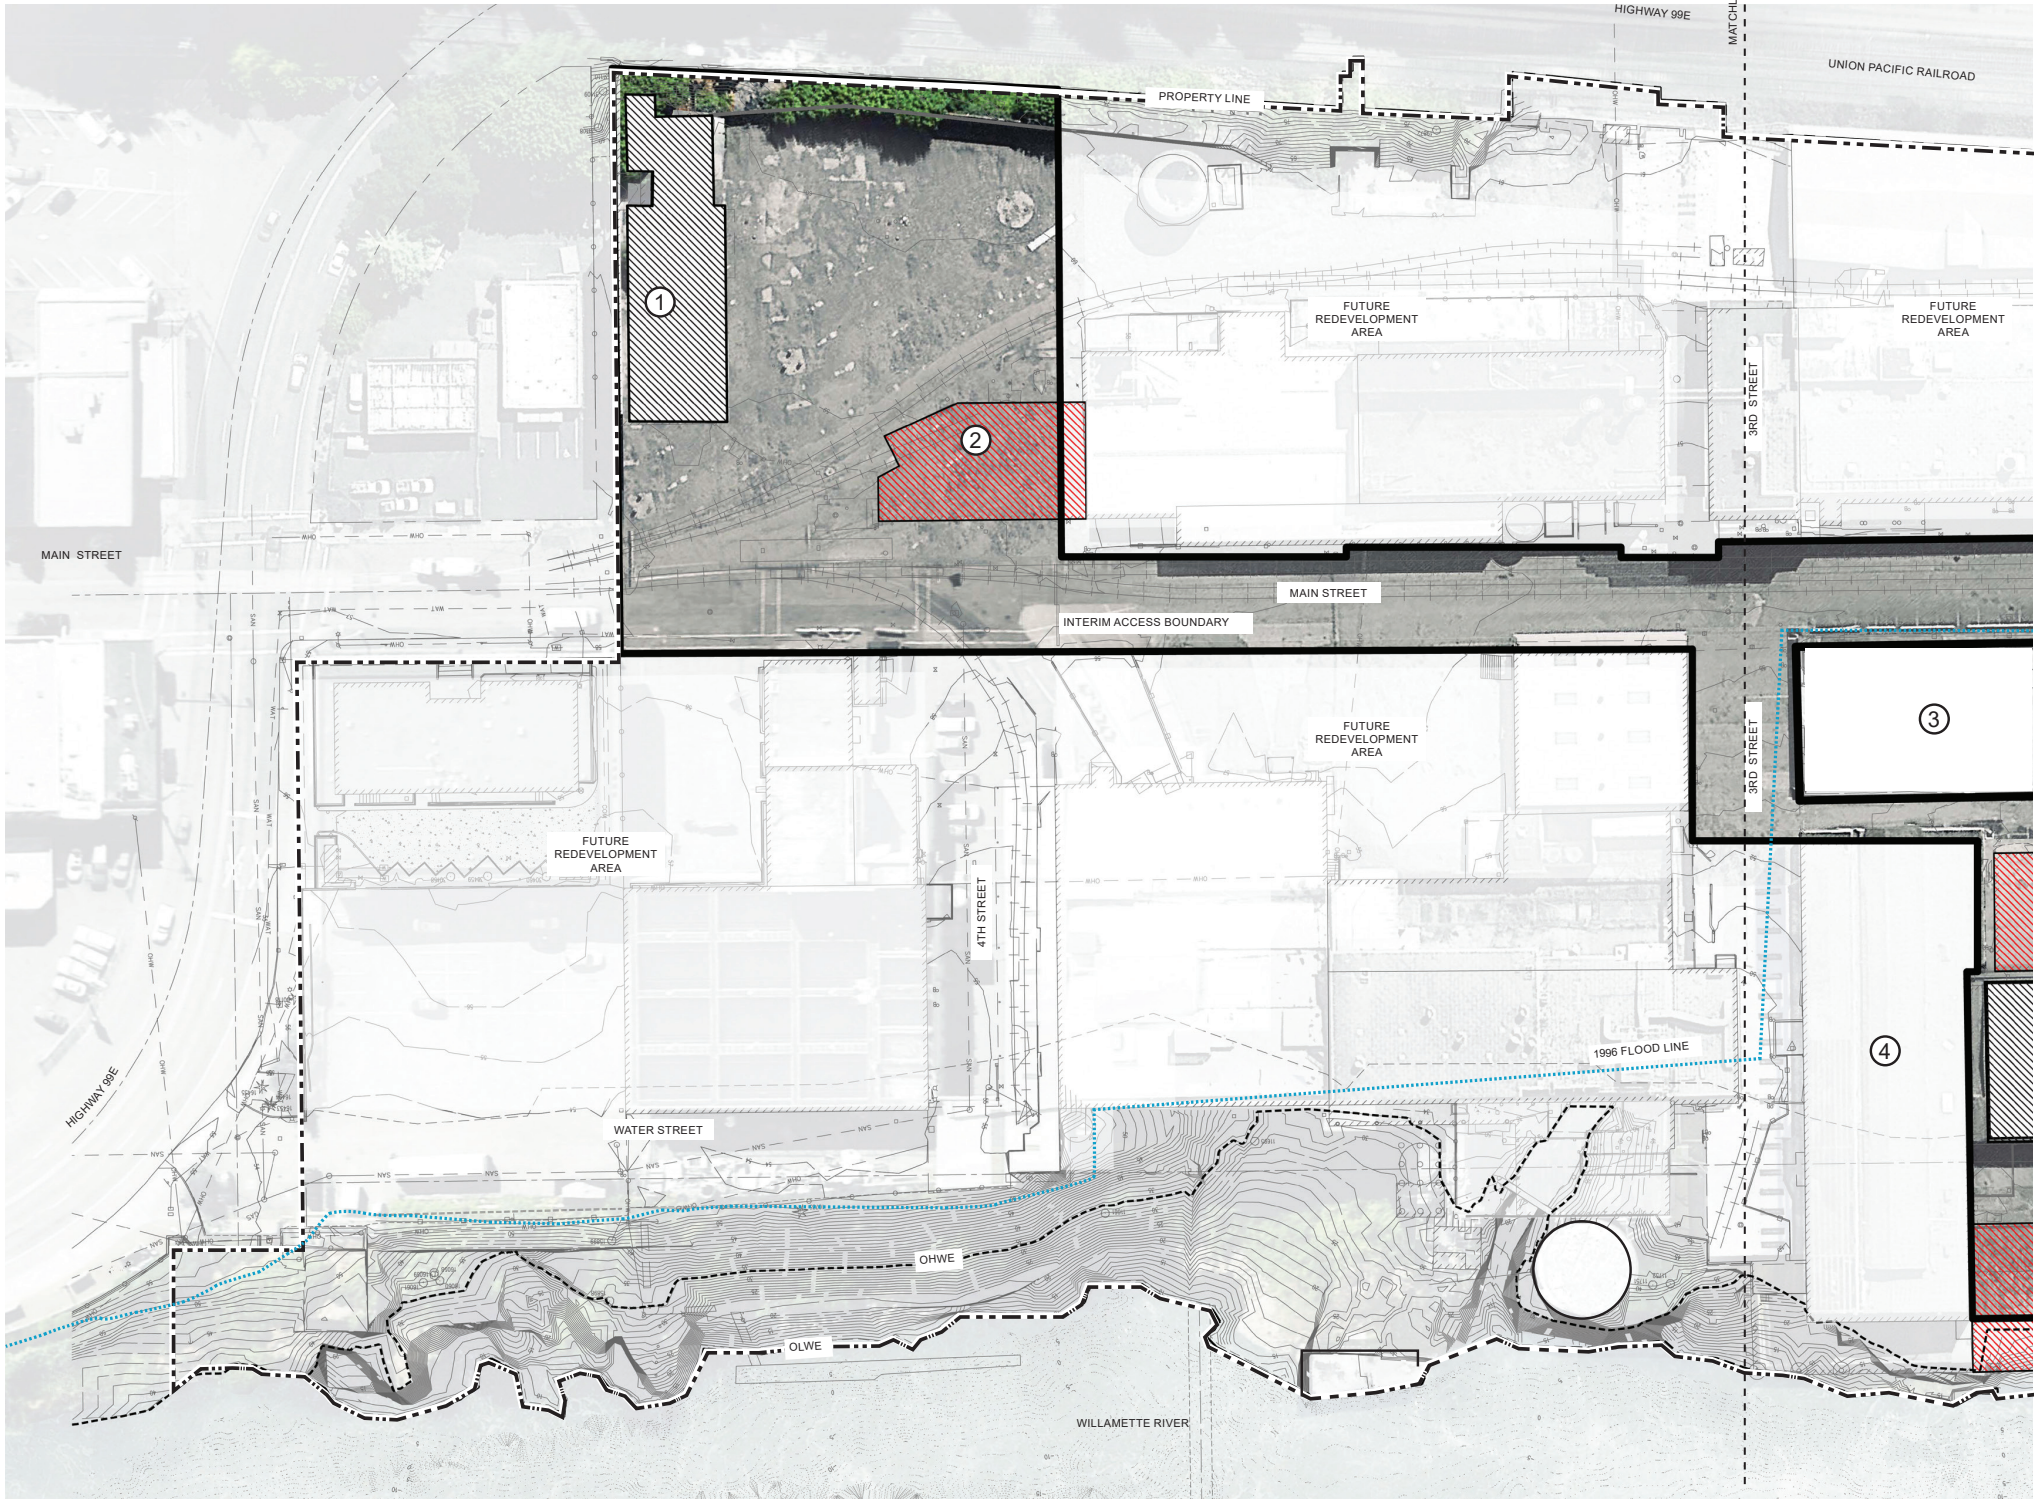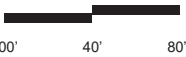

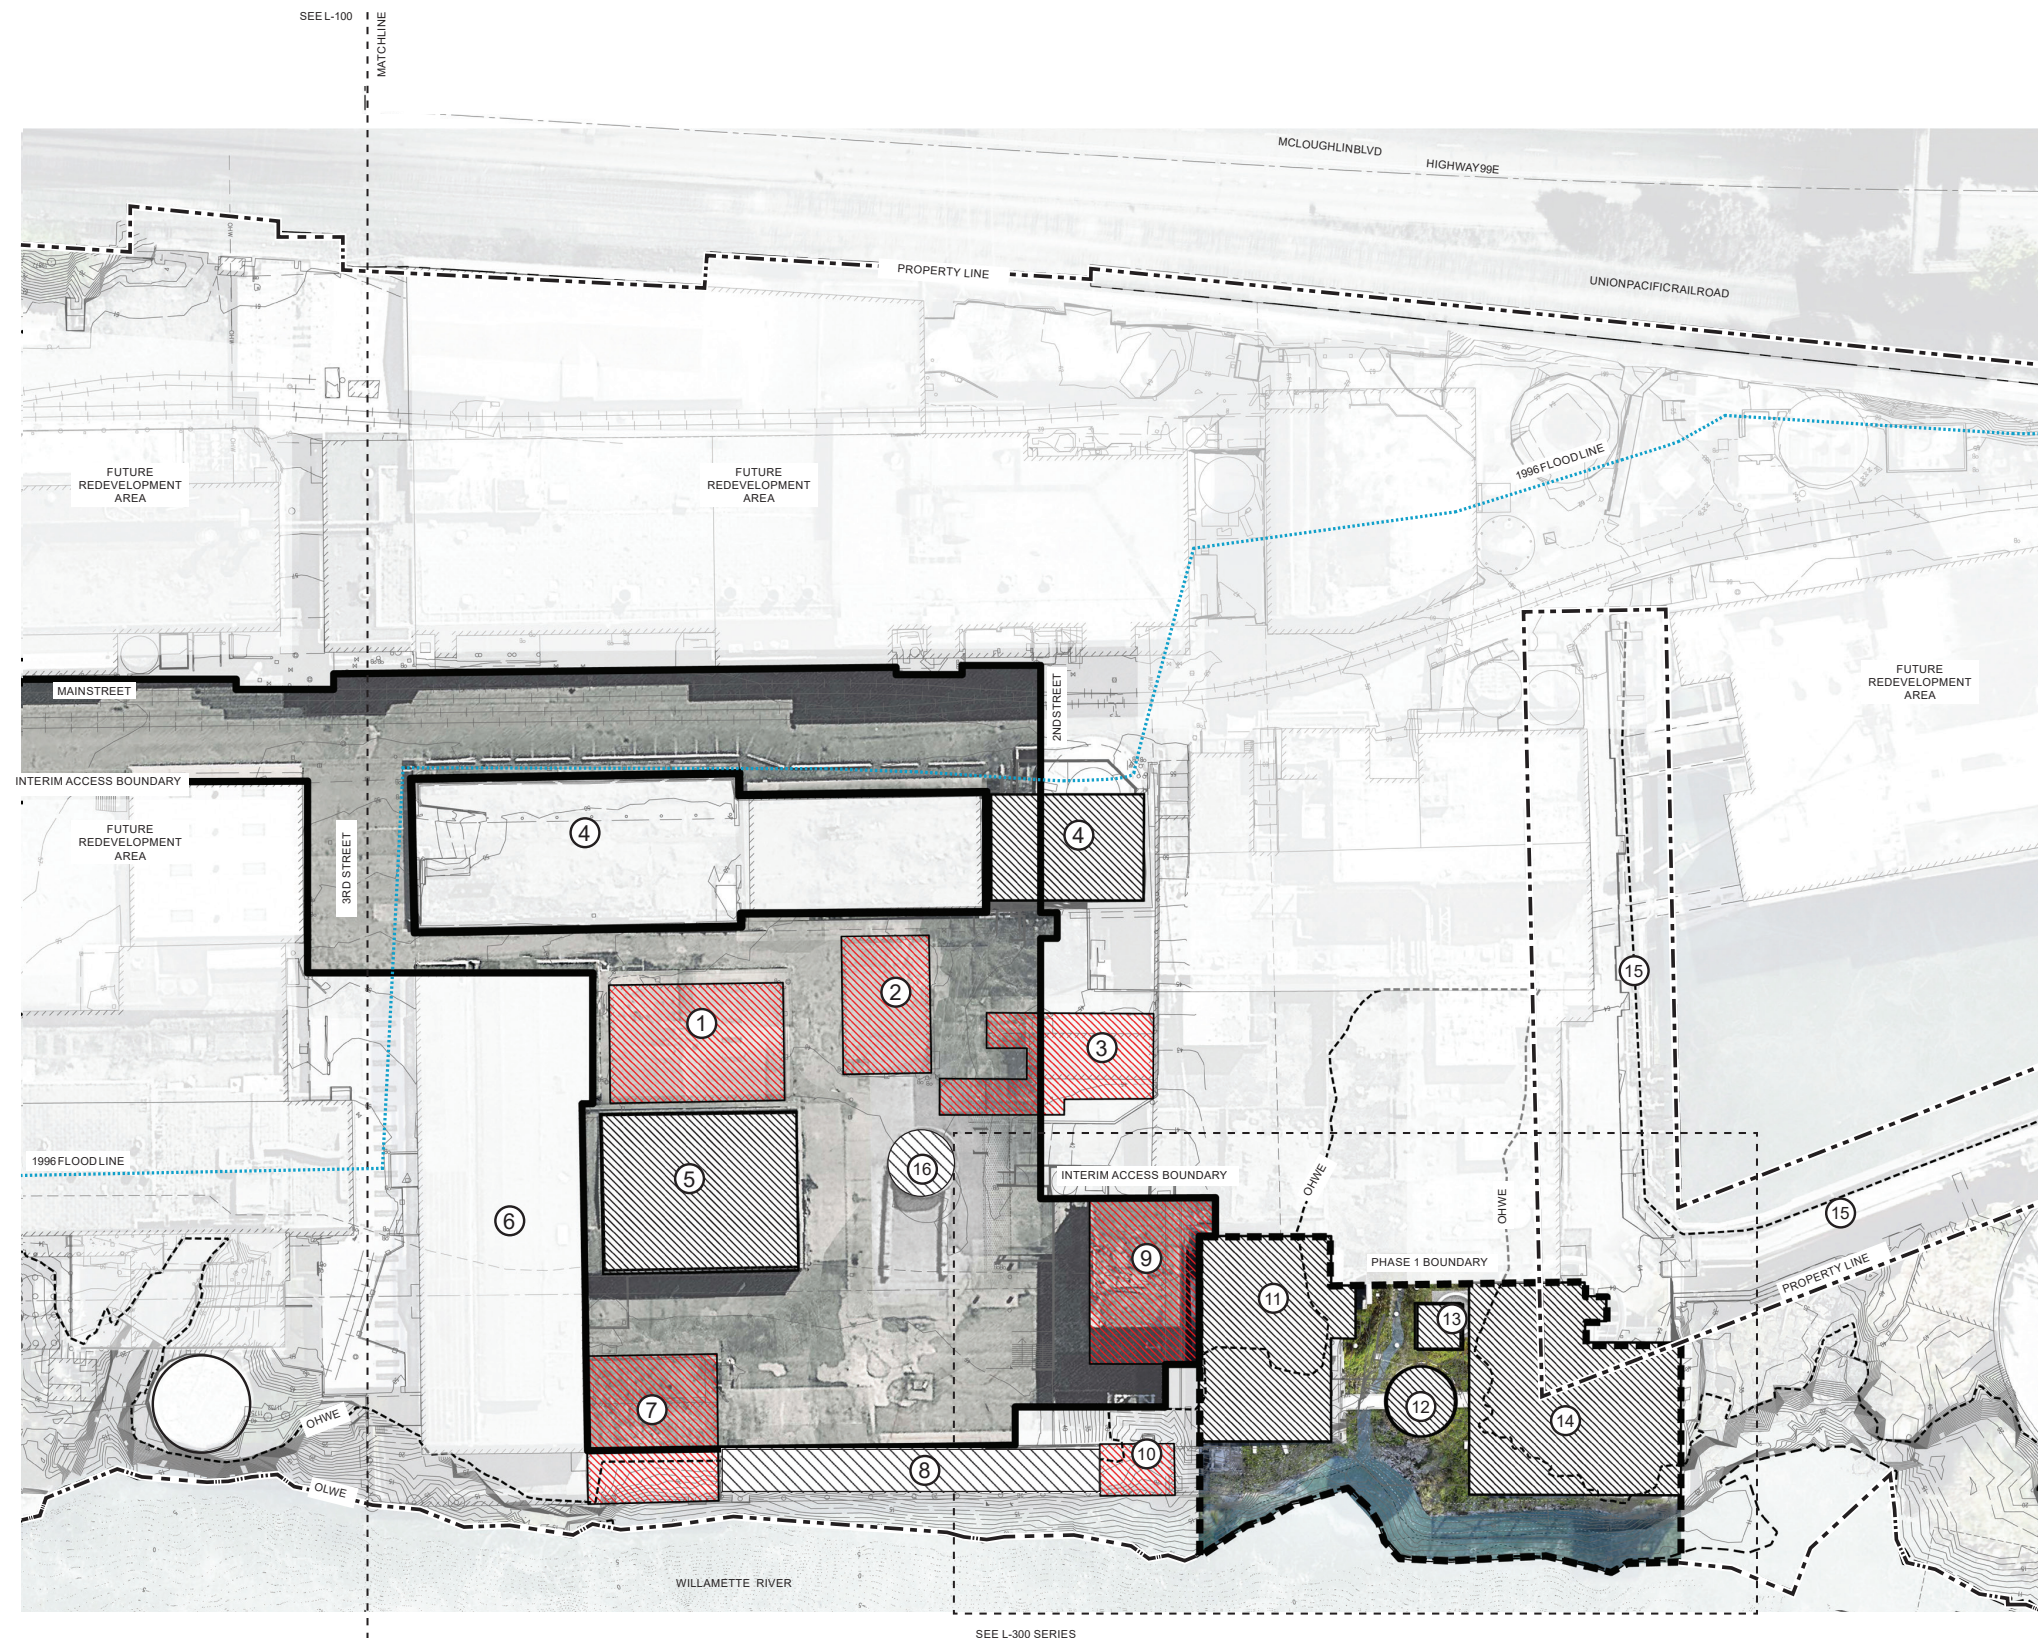

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- ALL LOOSE DEBRIS AND HAZARDOUS MATERIAL TO BE REMOVED IN INTERIM AREA.





SYMBOL LEGEND

- | | |
|---|----------------------------------|
|  | PROPERTY LINE |
|  | PHASE 1 BOUNDARY |
|  | INTERIM ACCESS AREA |
|  | 1996 FLOOD LINE |
|  | STRUCTURES TO BE REMOVED |
|  | STRUCTURES FOR REUSE |
|  | OHWE (ORDINARY HIGH WATER ELEV.) |
|  | OLWE (ORDINARY LOW WATER ELEV.)* |
| *MAY OVERLAP WITH PROPERTY LINE | |

PROGRAM LEGEND

- 1 MILLWRIGHT SHOP
- 2 AUTOSHOP
- 3 SOUTH SUBSTATION
- 4 WOOLEN MILL FOUNDATION
- 5 CARPENTRY SHOP
- 6 MILL O
- 7 PIPE SHOP
- 8 PIPE CHASE
- 9 RECOVERY BOILER (REMOVE CLADDING)
- 10 PUMP STATION (REMOVE STEEL FRAME
DOWN TO PIPE CHASE)
- 11 BOILER PLANT
- 12 HIGH DENSITY STOCK CYLINDER (REMOVE
SHED ONLY)
- 13 BRIGHTENING TOWER
- 14 MILL H
- 15 PGE DAM
- 16 REMNANT CYLINDER

GENERAL NOTES:

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- INTERIM ACCESS LINE DOES NOT INDICATE A LIMIT OF WORK AREA. REFER TO DRAWING FOR BUILDINGS OUTSIDE OF INTERIM ACCESS LINE THAT WILL BE PRESERVED OR REMOVED.

- ALL LOOSE DEBRIS AND HAZARDOUS MATERIAL TO BE REMOVED IN INTERIM AREA.

- KPFF STRUCTURAL COMMENT: YARD AREA – FILL BEHIND PIPECHASE SHOULD BE CONSIDERED FOR SEISMIC STABILIZATION. CONCERNS RELATE TO LATERAL LOADING ON PIPECHASE DURING A SEISMIC EVENT AND POTENTIAL SETTLING/LIQUIFICATION OF FILL MATERIALS.



NOT FOR CONSTRUCTION

SYMBOL LEGEND

- PROPERTY LINE
- INTERIM ACCESS AREA
- 1996 FLOOD LINE
- INTERIM ACCESS FENCE
- ↔ EMERGENCY VEHICULAR ACCESS
- EXISTING WATER LINE
- PROPOSED WATER LINE
- NEW DRY STANDPIPE
- ADA ACCESS PATH
- EXISTING ENCLOSED BUILDING
- TEMPORARY RESTROOM
- BICYCLE PARKING
- OHWE (ORDINARY HIGH WATER ELEV.)
- OLWE (ORDINARY LOW WATER ELEV.)*
- *MAY OVERLAP WITH PROPERTY LINE

PROGRAM LEGEND

- 1 SITE ENTRANCE
- 2 INTERIM PARKING LOT
- 3 BICYCLE PARKING
- 4 ACCESS PATH
- 5 MAIN STREET GATE
- 6 3RD STREET GATE
- 7 MILL O
- 8 WOOLEN MILL FOUNDATION
- 9 EXISTING HYDRANT (PROTECT)
- 10 TEMPORARY RESTROOM
- 11 EMERGENCY, SERVICE, SECURITY, ACCESS GATE

GENERAL NOTES:

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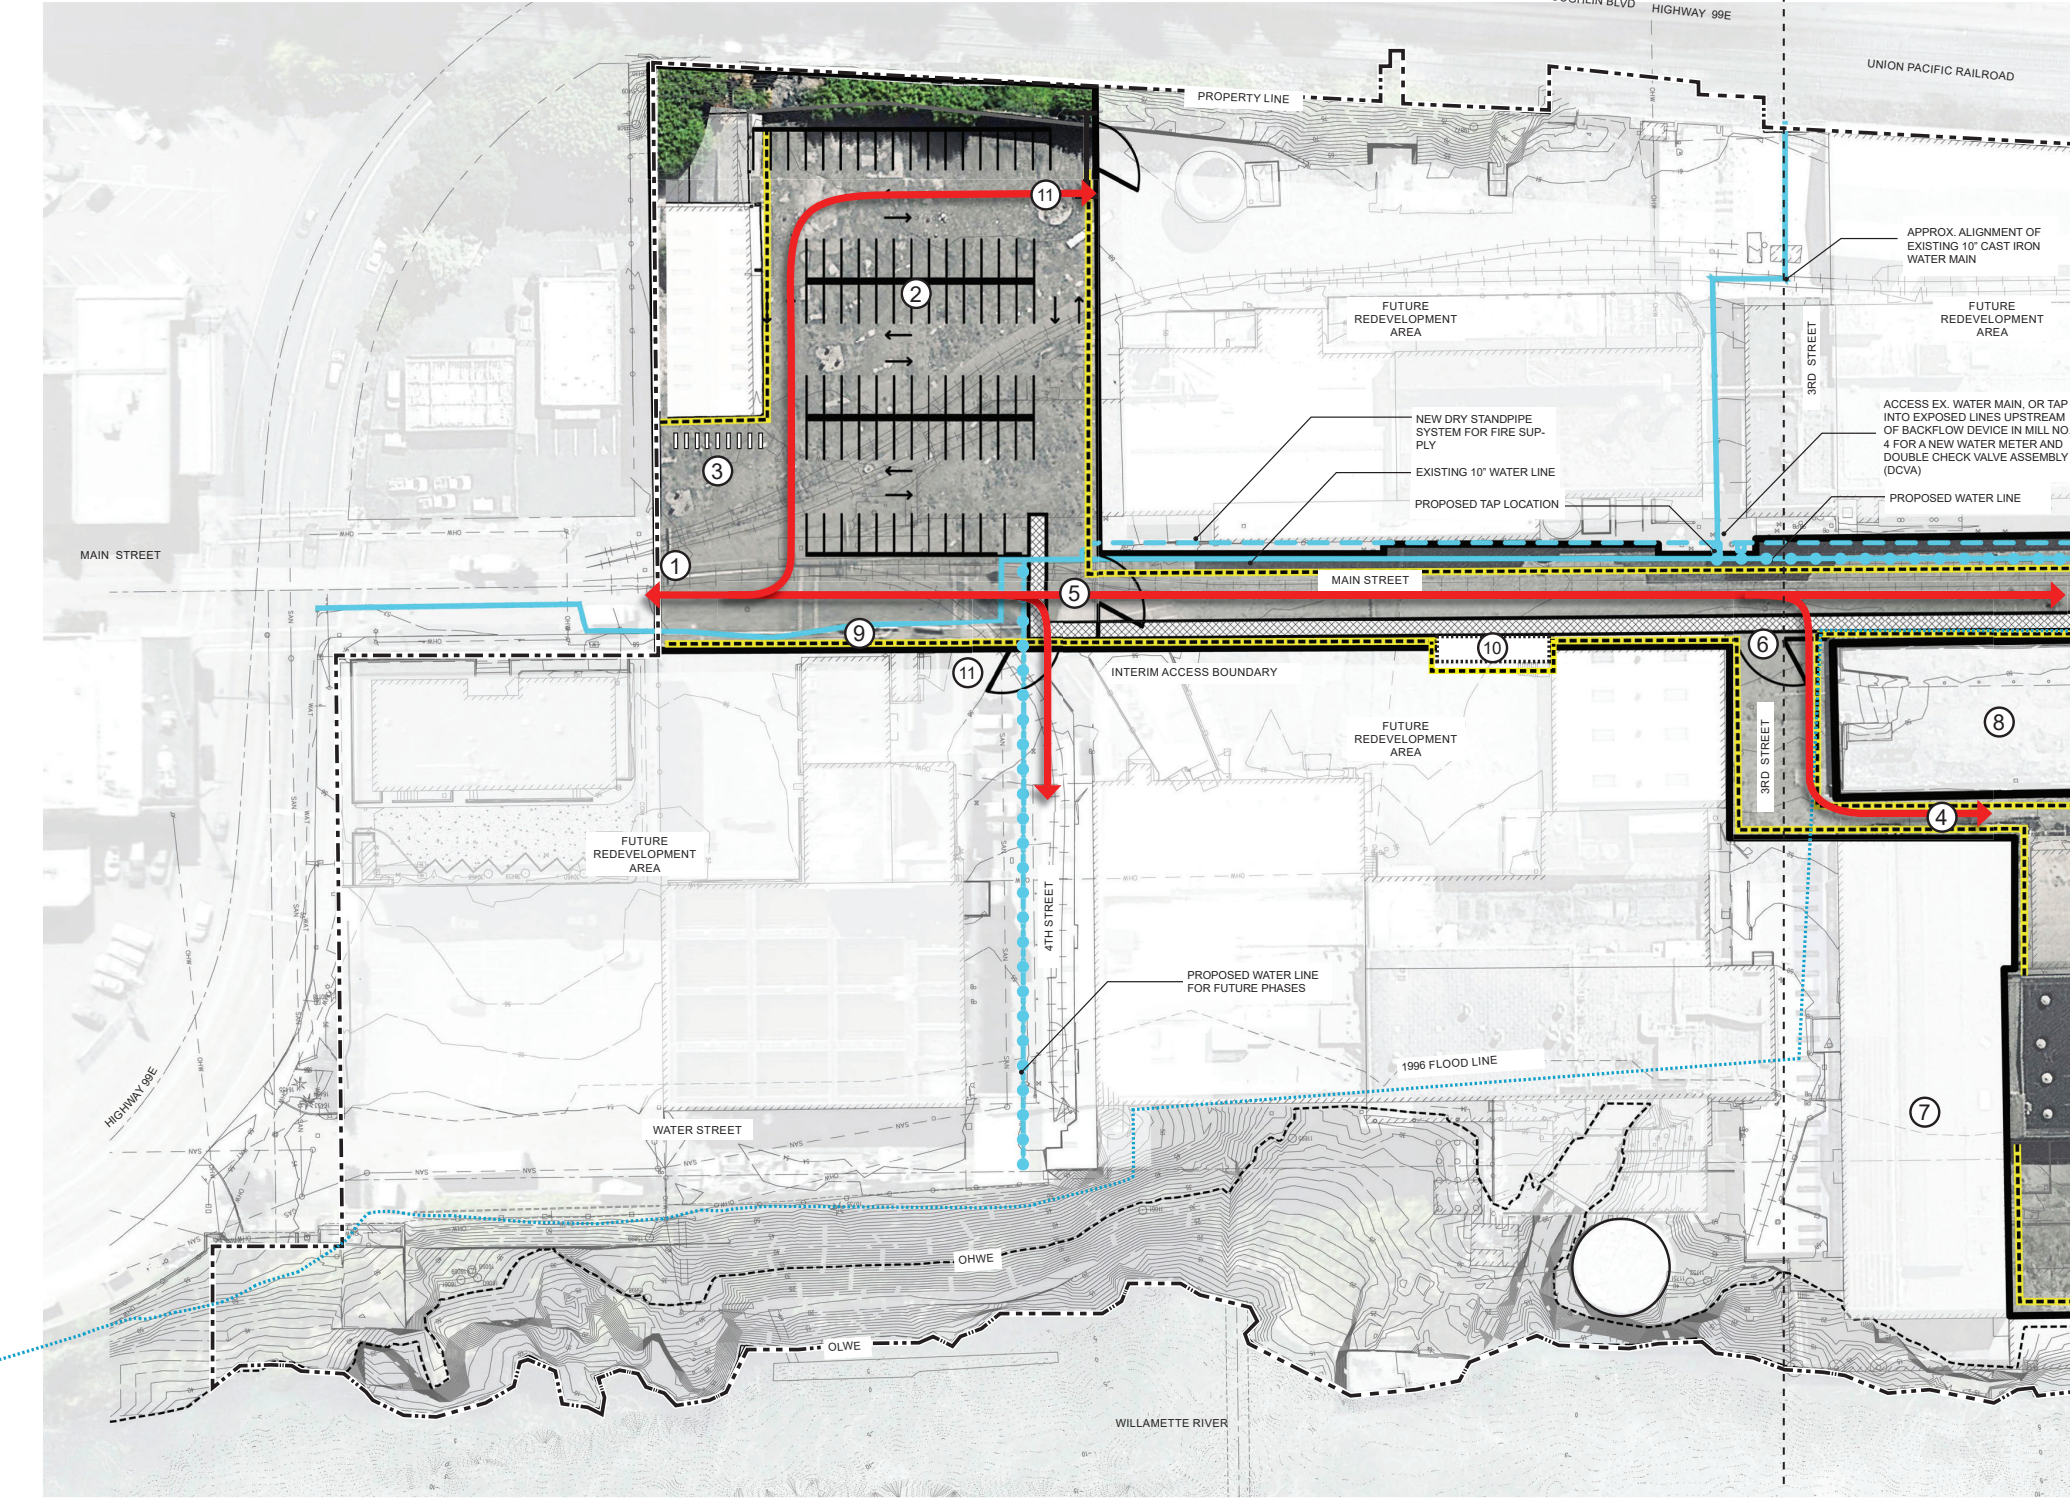
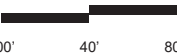
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- KPFF STRUCTURAL COMMENT: GENERAL – PROPOSED PHASE I DESIGN BASED UPON FINDINGS OF KPFF STRUCTURAL EVALUATION REPORT. PLANS AND SECTIONS BASED UPON SITE SURVEY INFORMATION INCLUDED WITHIN KPFF STRUCTURAL EVALUATION REPORT AND METRO SITE SURVEY. ALL EXISTING AND PROPOSED ELEMENTS ARE CONCEPTUAL IN THEIR LEVEL OF REFINEMENT, AND REQUIRE VERIFICATION IN FIELD.

- KPFF CIVIL- EXISTING WATER MAINS THAT ARE CURRENTLY ABANDONED SOUTH OF THE DOUBLE CHECK IN MILL H ARE NOT IN AN ACCEPTABLE CONDITION FOR REUSE.

- KPFF CIVIL- REUSE OF EXISTING IMPERVIOUS AREAS OR BUILDING PADS AFTER DEMOLITION OF STRUCTURES WILL NOT TRIGGER STORMWATER REQUIREMENTS. HOWEVER, TARGET WATER QUALITY TREATMENT, OR AT A MINIMUM IMPLEMENT MEASURES TO CAPTURE SEDIMENT AND DEBRIS PRIOR TO DISCHARGE TAILRACE ARE RECOMMENDED.

- TEMPORARY RESTROOM (TRAILER) POTENTIAL FOR CONNECTION TO SEWER. TO BE DETERMINED BY DESIGN-BUILD TEAM.



1 INTERIM ACCESS 1
SCALE: 1" = 40' - 0"



SCALE: 1" = 40' - 0"

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CLIENT CONSULTANTS:

WATER RESOURCE ENGINEERING CH2M 2020 SW 4TH AVENUE, SUITE 300 PORTLAND, OR 97201 (503) 235-5000	HABITAT RESTORATION STILLWATER SCIENCES 108 NW NINTH AVENUE, SUITE 200 PORTLAND, OR 97209 (503) 267-9006
---	--

ENVIRONMENTAL ENGINEERING
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PORTLAND, OR 97209
(503) 544-2138

SEAL

Willamette Falls
RIVERWALK PROJECT

PHASE 1
EXISTING AND RE-
MOVALS ELEVATION

DRAWN: EG CHECKED: MM
PLOT DATE: 6/29/2018

L- 200

DRAWING NO:

SYMBOL LEGEND

- FULL REMOVAL
- PARTIAL REMOVAL AND RE-USE

PROGRAM LEGEND

- 1 THE YARD
- 2 PIPE CHASE
- 3 PUMP STATION
- 4 RECOVERY BOILER
- 5 BOILER PLANT
- 6 HIGH DENSITY STOCK CYLINDER SHED
- 7 HIGH DENSITY STOCK CYLINDER
- 8 MILL H
- 9 MILL H REJECT
- 10 MILL H TOWER

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- KPFF STRUCTURAL COMMENT: YARD AREA – FILL BEHIND PIPECHASE SHOULD BE CONSIDERED FOR SEISMIC STABILIZATION. CONCERNS RELATE TO LATERAL LOADING ON PIPECHASE DURING A SEISMIC EVENT AND POTENTIAL SETTLING/LIQUIFICATION OF FILL MATERIALS.


OVERLOOK ELEVATION
EL. +79.0'

DAM ELEVATION
EL. +64.0'

PUBLIC YARD ELEVATION
EL. +46.0'

ORDINARY HIGH WATER ELEVATION (OHWE)
EL. +33.4'

ORDINARY LOW WATER ELEVATION (OLWE)
EL. +9.0'

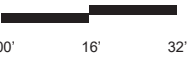

1 EXISTING ELEVATION AND REMOVALS
SCALE: 1/16" = 1'-0"



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- SUBGRADE PLANTING CONDITION IN MILL H TO BE RESOLVED BY DESIGN-BUILD TEAM.
- KPFF STRUCTURAL COMMENT: YARD AREA – FILL BEHIND PIPECHASE SHOULD BE CONSIDERED FOR SEISMIC STABILIZATION. CONCERNS RELATE TO LATERAL LOADING ON PIPECHASE DURING A SEISMIC EVENT AND POTENTIAL SETTLING/LIQUIFICATION OF FILL MATERIALS.



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CLIENT



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---	--

CLIENT CONSULTANTS:

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SEAL

Willamette Falls
RIVERWALK PROJECT

PHASE 1
SECTION 1

DRAWN: EG
PLOT DATE: 6/29/2018

L- 201

DRAWING NO.



SEE L-302-ALT FOR ALTERNATIVE ROOF ACCESS



PHASE I LONGITUDINAL SECTION LOOKING WEST

SCALE: 1/16" = 1'-0"

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ISSUED FOR

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PORTLAND, OR, 97209
(971) 544-2139

CIVIL ENGINEERING
KPFF
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PORTLAND, OR, 97204
(503) 227-3251

HABITAT RESTORATION
STILLWATER SCIENCES
108 NW NINTH AVENUE, SUITE 200
PORTLAND, OR, 97209
(503) 267-9006

SEAL


Willamette Falls
RIVERWALK PROJECT


PHASE 1
SECTION 2

DRAWN: EG
PLOT DATE: 6/29/2018

L- 202

DRAWING NO.

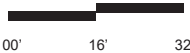

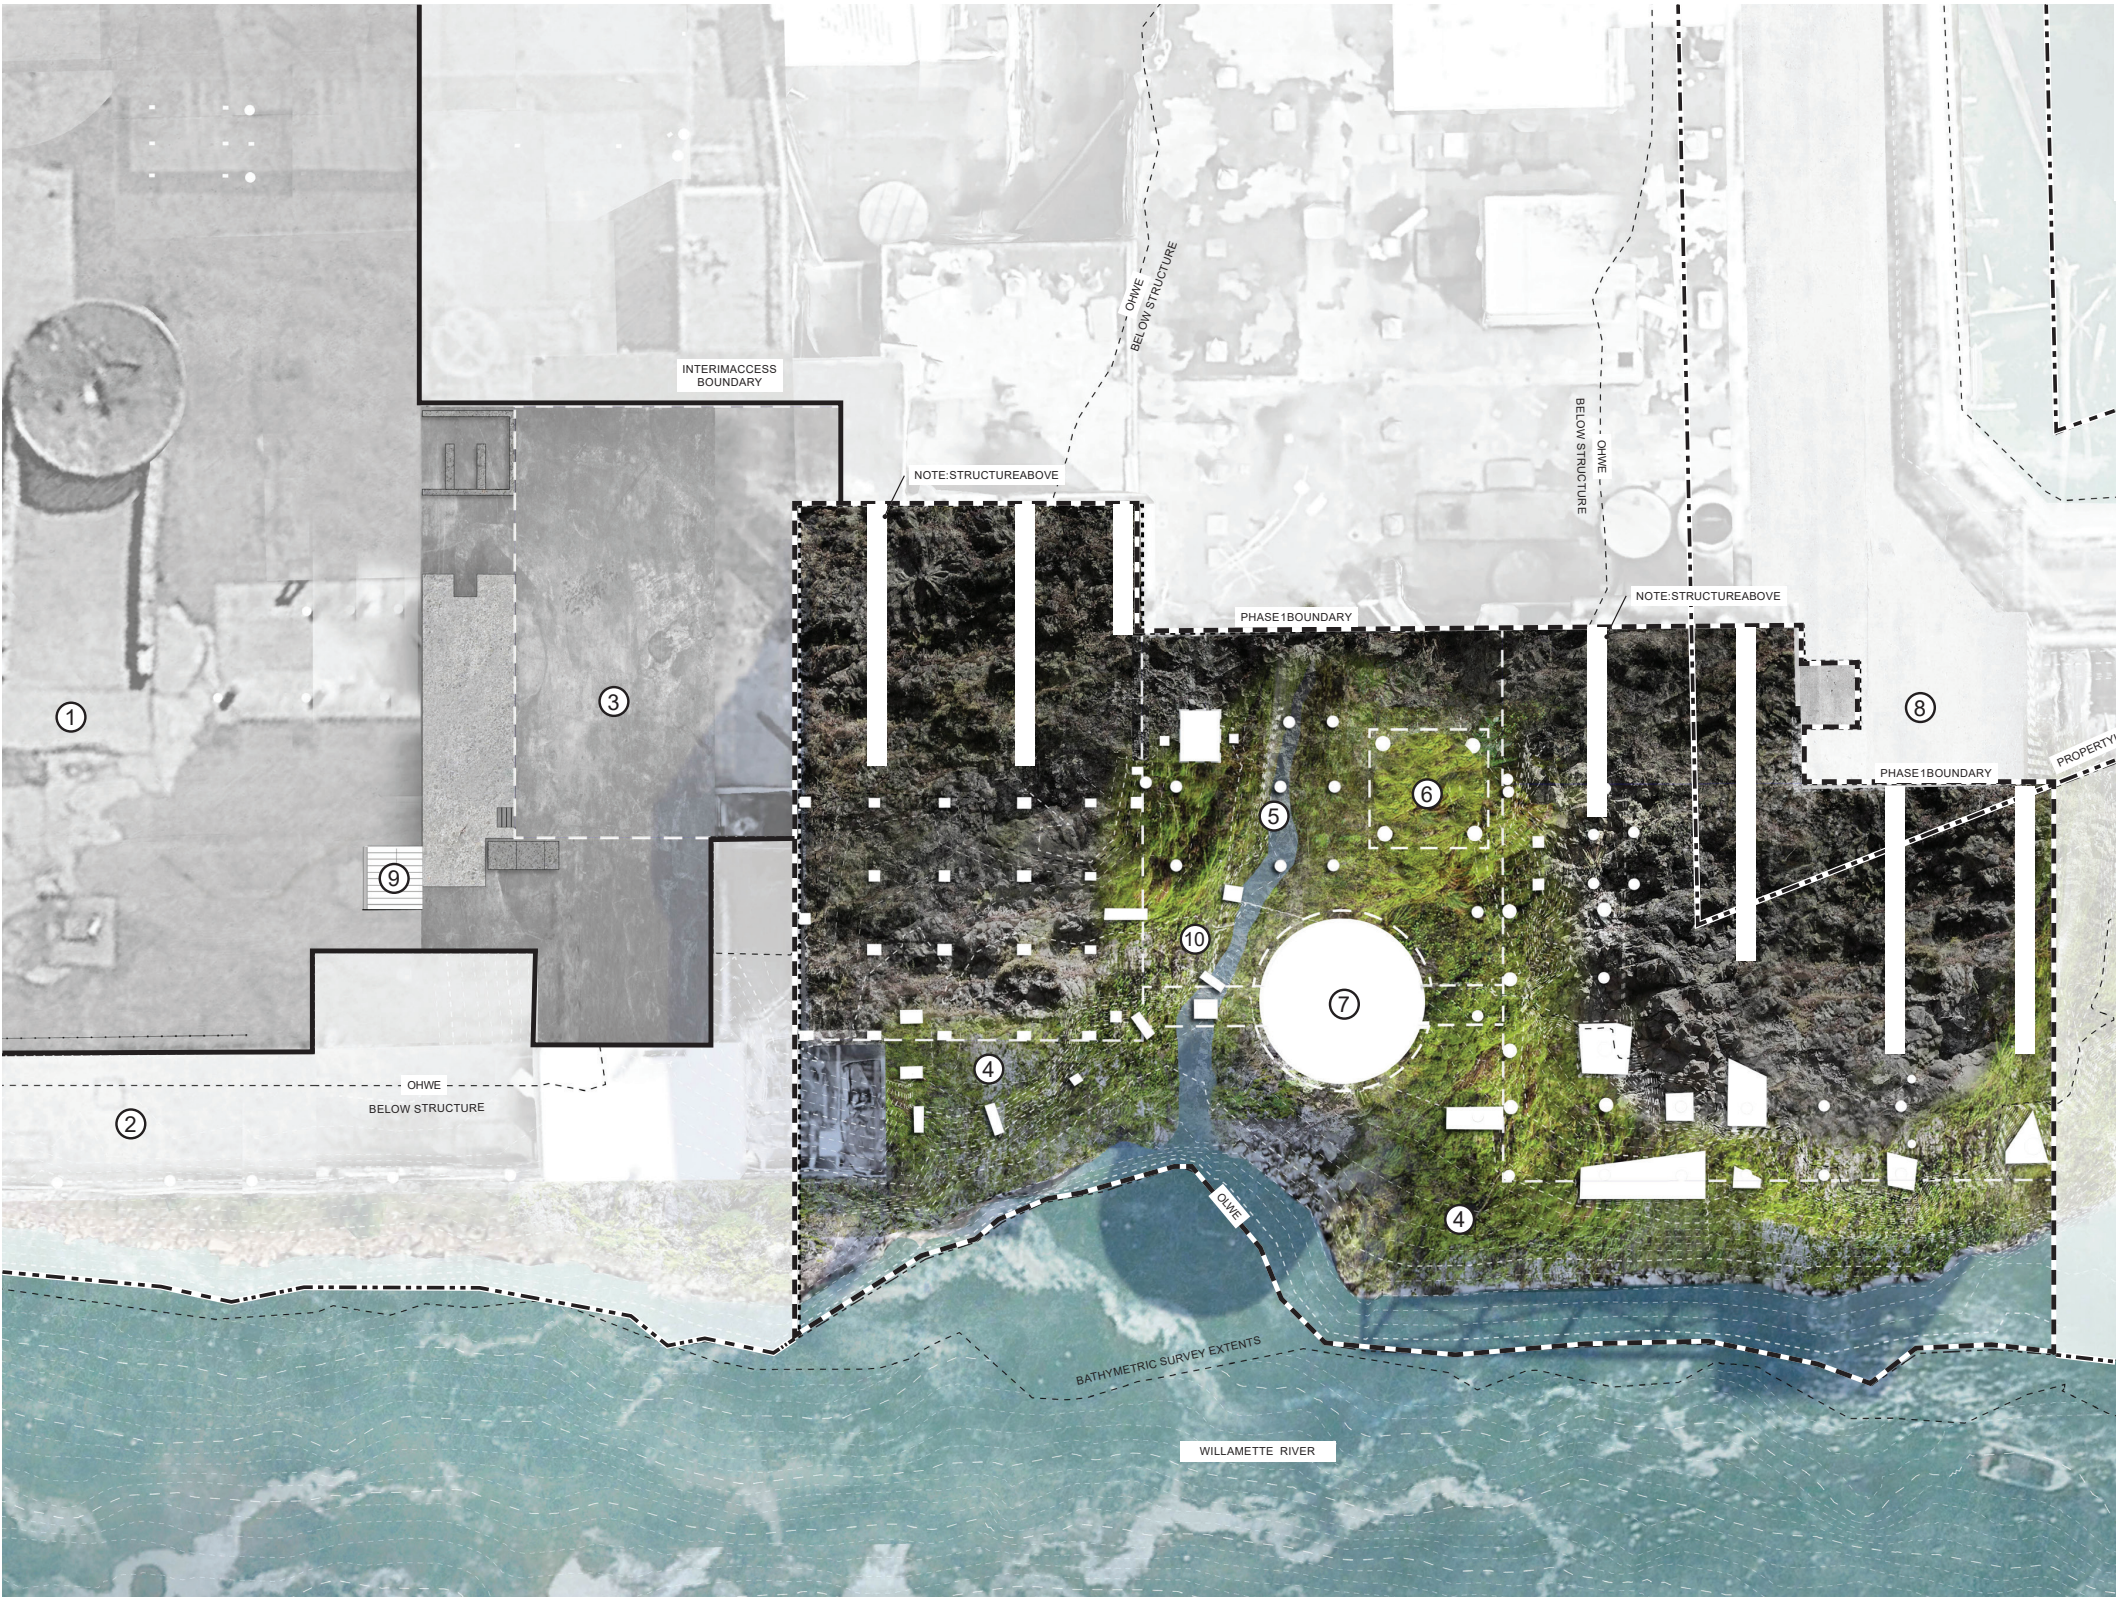

SYMBOL LEGEND

- PROPERTY LINE
- PHASE 1 BOUNDARY
- INTERIM ACCESS AREA
- OHWE (ORDINARY HIGH WATER ELEV.)
- OLWE (ORDINARY LOW WATER ELEV.)*
- *MAY OVERLAP WITH PROPERTY LINE

PROGRAM LEGEND

- PUBLIC YARD
- PIPE CHASE
- RECOVERY BOILER BASE
- RIPARIAN BASALT HABITAT RESTORATION
- OFF-CHANNEL ALCOVE HABITAT RESTORATION
- BRIGHTENING TOWER BASE
- STOCK CYLINDER BASE
- PGE DAM
- INTERIM STAIR
- WEIR STRUCTURE (TO BE REMOVED DOWN TO BASALT)

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- SYMBOL LEGEND
- PROPERTY BOUNDARY
 - PHASE 1 BOUNDARY
 - INTERIM ACCESS AREA
 - GRATING
 - OHWE (ORDINARY HIGH WATER ELEV.)
 - OLWE (ORDINARY LOW WATER ELEV.)*
 - *MAY OVERLAP WITH PROPERTY LINE

- PROGRAM LEGEND
- 1 PUBLIC YARD
 - 2 PIPE CHASE
 - 3 RECOVERY BOILER BASE
 - 4 BOILER PLANT
 - 5 HIGH DENSITY STOCK CYLINDER 2
 - 6 BRIGHTENING TOWER (CONSIDER FOR SWIFT HABITAT)
 - 7 MILL H TOWER
 - 8 MILL H GROVE
 - 9 PGE DAM
 - 10 INTERIM ACCESS FROM STREET / YARD
 - 11 TOUR STAGING AREA
 - 12 EMERGENCY ACCESS LOCATION
 - 13 STAIR TO OVERLOOK
 - 14 EXPLORER TRAIL
 - 15 MAINTENANCE STORAGE

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CLIENT CONSULTANTS:

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(503) 544-2138

SEAL

Willamette Falls
RIVERWALK PROJECT

PHASE 1
DAM LEVEL PLAN

DRAWN: EG
PLOT DATE: 6/29/2018

CHECKED: MM

L- 301

DRAWING NO:

1

PHASE 1 PLAN AT DAM LEVEL - ELEV 66'-0"

SCALE: 1/16" = 1'-0"





SYMBOL LEGEND

- PROPERTY LINE
- PHASE 1 BOUNDARY
- INTERIM ACCESS AREA
- GRATING
- OHWE (ORDINARY HIGH WATER ELEV.)
- OLWE (ORDINARY LOW WATER ELEV.)*
- *MAY OVERLAP WITH PROPERTY LINE

PROGRAM LEGEND


- PUBLIC YARD
- PIPE CHASE
- RECOVERY BOILER BASE
- BOILER PLANT
- HIGH DENSITY STOCK CYLINDER 2
- BRIGHTENING TOWER (CONSIDER FOR SWIFT HABITAT)
- MILL H TOWER
- MILL H GROVE
- PGE DAM
- INTERIM ACCESS FROM STREET / YARD
- TOUR STAGING AREA
- EMERGENCY ACCESS LOCATION
- STAIR TO OVERLOOK
- EXPLORER TRAIL
- MAINTENANCE STORAGE
- UPPER OVERLOOK


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- KPFF STRUCTURAL COMMENT: YARD AREA – FILL BEHIND PIPECHASE SHOULD BE CONSIDERED FOR SEISMIC STABILIZATION. CONCERNS RELATE TO LATERAL LOADING ON PIPECHASE DURING A SEISMIC EVENT AND POTENTIAL SETTLING/LIQUIFICATION OF FILLMATERIALS.

1 PHASE 1 PLAN AT OVERLOOK - ELEV 81'-0"

SCALE: 1/16" = 1'-0"



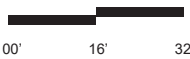

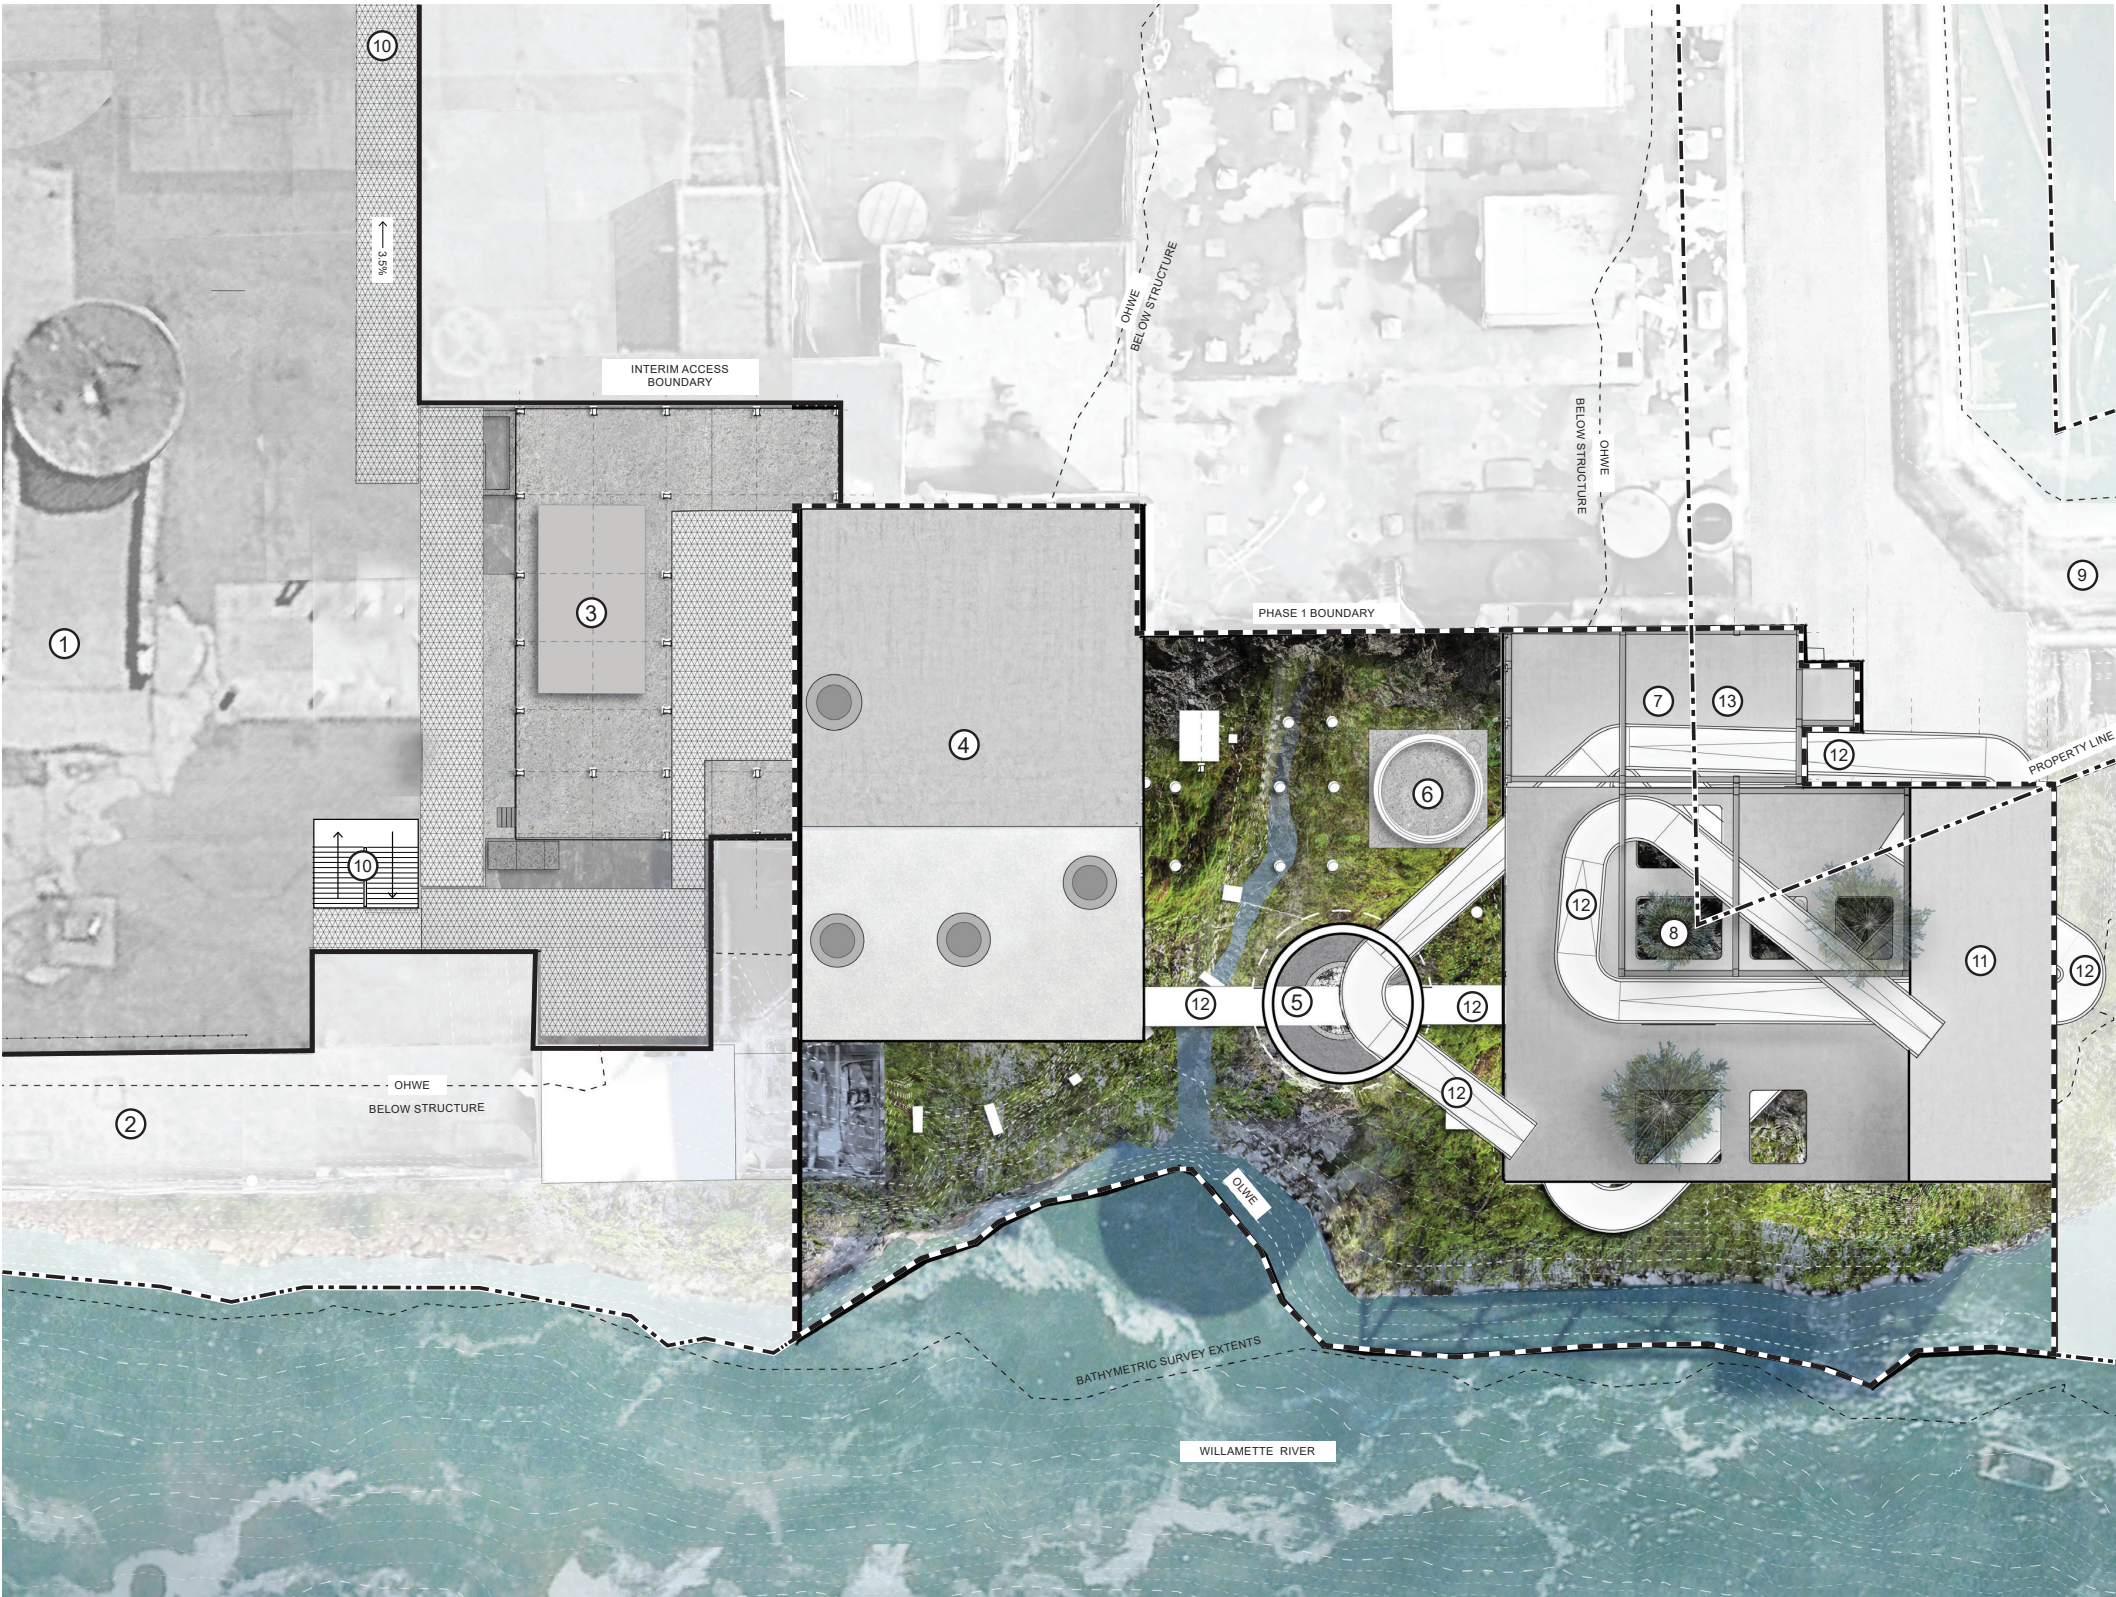SYMBOL LEGEND

- PROPERTY LINE
- PHASE 1 BOUNDARY
- INTERIM ACCESS AREA
- GRATING
- OHWE (ORDINARY HIGH WATER ELEV.)
- OLWE (ORDINARY LOW WATER ELEV.)*
- *MAY OVERLAP WITH PROPERTY LINE


PROGRAM LEGEND

- PUBLIC YARD
- PIPE CHASE
- RECOVERY BOILER BASE
- BOILER PLANT (ROOF)
- HIGH DENSITY STOCK CYLINDER 2
- BRIGHTENING TOWER (CONSIDER FOR SWIFT HABITAT)
- MILL H TOWER
- MILL H GROVE (BELOW)
- PGE DAM
- INTERIM ACCESS FROM STREET / YARD
- UPPERMOST OVERLOOK PLATFORM
- EXPLORER TRAIL
- POTENTIAL PLAY ELEMENT

GENERAL NOTES:

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DEVIATIONS FROM THE CONTRACT DOCUMENTS WITHOUT WRITTEN APPROVAL FROM THE CONSULTANT ARE SUBJECT TO CORRECTION AT THE CONTRACTOR'S EXPENSE.

CLIENT

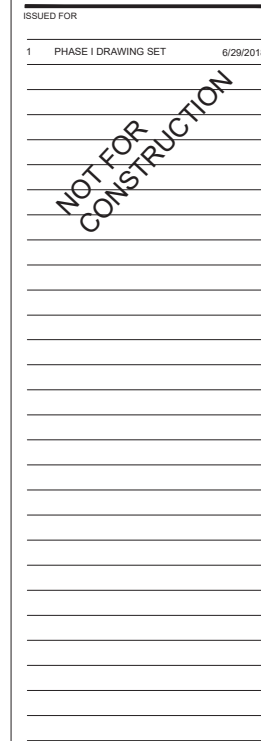

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SEAL




PHASE 1
STRUCTURAL +
UTILITIES PLAN

DRAWN: EG
PLOT DATE: 6/29/2018

L- 303

DRAWING NO:

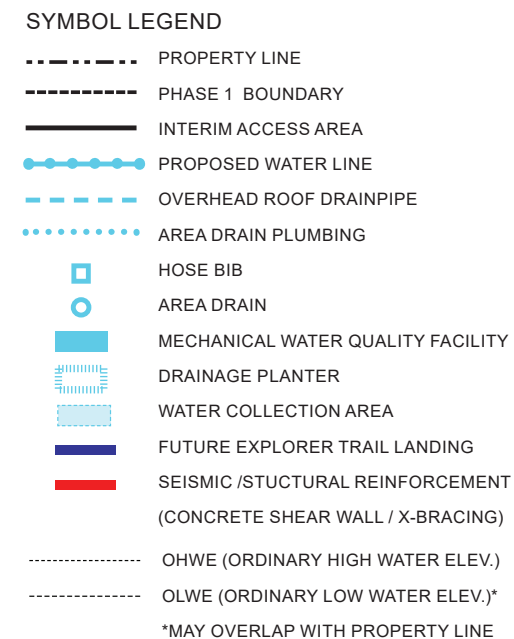

NOTES:

- KPFF STRUCTURAL COMMENT: GENERAL – PROPOSED PHASE I DESIGN BASED UPON FINDINGS OF KPFF STRUCTURAL EVALUATION REPORT. PLANS AND SECTIONS BASED UPON SITE SURVEY INFORMATION INCLUDED WITHIN KPFF STRUCTURAL EVALUATION REPORT AND METRO SITE SURVEY. ALL EXISTING AND PROPOSED ELEMENTS ARE CONCEPTUAL IN THEIR LEVEL OF REFINEMENT, AND REQUIRE VERIFICATION IN FIELD.

- KPFF STRUCTURAL COMMENT: YARD AREA - FILL BEHIND PIPECHASE SHOULD BE CONSIDERED FOR SEISMIC STABILIZATION. CONCERNS RELATE TO LATERAL LOADING ON PIPECHASE DURING A SEISMIC EVENT AND POTENTIAL SETTLING/LIQUIFICATION OF FILL MATERIALS.

- KPFF STRUCTURAL COMMENT: STOCK CYLINDER #2
- THE PROPOSED OPENINGS AND EXPLORER TRAIL STRUCTURES ASSOCIATED WITH STOCK CYLINDER #2 ARE FEASIBLE. FUTURE WORK TO REFINER STRUCTURAL ANALYSIS OF OPENINGS, LOADS, AND CONNECTIONS BETWEEN EXISTING AND PROPOSED STRUCTURES TO DETERMINE NECESSARY UPGRADES.

- KPFF STRUCTURAL COMMENT: MILL H GROVE STRUCTURE - WITH STEEL PLATE REINFORCEMENTS AND SELECTIVE REPLACEMENT OF EXISTING STEEL COLUMNS AND BEAMS, THE MILL H GROVE STRUCTURE MAY SUPPORT THE PROPOSED EXPLORER TRAIL TO THE MID-LEVEL OVERLOOK. IN ADDITION, REINFORCEMENTS TO THE STEEL MEMBERS OF THE ROOF STRUCTURE MAY ALLOW THE EXPLORER TRAIL TO BE SUSPENDED.

- KPFF STRUCTURAL- NEW CONCRETE SHEAR WALL TO BE 12-18" THICK. NEW STEEL X-BRACING TO BE 8X8".

-KPFF CIVIL- EXISTING WATER MAINS THAT ARE CURRENTLY ABANDONED SOUTH OF THE DOUBLE CHECK IN MILL H ARE NOT IN AN ACCEPTABLE CONDITION FOR REUSE.

-KPPF CIVIL- REUSE OF EXISTING IMPERVIOUS AREAS OR BUILDING PADS AFTER DEMOLITION OF STRUCTURES WILL NOT TRIGGER STORMWATER REQUIREMENTS. HOWEVER, TARGET WATER QUALITY TREATMENT, OR AT A MINIMUM IMPLEMENT MEASURES TO CAPTURE SEDIMENT AND DEBRIS PRIOR TO DISCHARGE TAILRACE ARE RECOMMENDED.

- A TOPPING SLAB SHOULD BE AVOIDED TO CONTROL DRAINAGE. IN ORDER TO PRESERVE AS MUCH OF THE ORIGINAL CHARACTER OF THE SITE, MOVE WATER THROUGH THE FOLLOWING SUBTRACTIVE METHODS AS AN ALTERNATIVE: CORING, GRINDING, CHANNELING, WEEPHOLES, GROOVES, ETC.

00' 16' 32'



GENERAL NOTES:

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1

PHASE 1- STRUCTURAL + UTILITIES PLAN

SCALE: 1/16" = 1'-0"

LIGHTING NOTES

1 TEMPORARY PARKING LIGHTING

CENTRAL MAST LIGHTING:
USING ONE, AND UP TO THREE, CENTRALLY
PLACED LIGHTING MASTS APPROX 40'-45',
WITH MULTIPLE HEADS, PROVIDE BLANKET
COVERAGE OF ENTIRE PARKING AREA FROM
ONE LOCATION.

PROS: CENTRALIZED ELECTRICAL SUPPLY;
MINIMAL IMPACT TO OVERALL SITE.

CONS: REQUIRE SUBSTANTIAL FOOTINGS;
PERIMETER ILLUMINATION FALL OFF,
GENERALLY NOT DARK SKY COMPLIANT (LONG
TERM REQUIREMENT).

2 TEMPORARY MAIN STREET LIGHTING

TEMPORARY PATHWAY LIGHTING:
EMBRACING THE UNFINISHED QUALITY OF THE SITE,
AS WELL AS CONSTRUCTION THAT WILL HAPPEN
OVER TIME, THE USE OF CAGED CONSTRUCTION
STRING LIGHTS MOUNTED TO FENCING WILL
LIGHT BOTH EDGES OF MAIN STREET, PROVIDING
SAFETY AND SECURITY LIGHTING. THESE FIXTURES
CAN BE MOVED, AND REPOSITIONED, AS NEEDED
THROUGHOUT DEVELOPMENT.

OPTION: PAINT WIRE PROTECTIVE "CAGE" A
SIGNATURE COLOR TO EMPHASIZE WAYFINDING.

3 CARPENTRY SHOP

LIGHTING OF CARPENTRY SHOP SHOULD
HIGHLIGHT IMPROVEMENTS AS PART OF THE
DESIGN-TEAM EFFORT

4 OPEN YARD LIGHTING

USING THE CATWALK AS A STRUCTURAL SKELETON,
POST MOUNTED AREA LIGHTING AFFIXED TO THE
SCAFFOLDING WILL GIVE MOST OF THE OPEN YARD
AREA LEVELS OF ILLUMINATION REQUIRED TO
MEET EMERGENCY CODES. CAGED CONSTRUCTION
STRING LIGHT WILL PROVIDE AN EDGE CONDITION
FOR THE FAR SIDE OF THE YARD.

PLATFORM LIGHTING:
USING SIMILAR TECHNIQUE, THE CATWALK
BECOMES THE FOUNDATION FOR HIGH-LEVEL
LIGHTING TO FILL THE PLATFORM SURFACE.

5 HABITAT EDGE

IN ORDER TO MINIMIZE IMPACT TO NATIVE SPECIES
LIVING IN THE SURROUNDING HABITAT, AND LIGHT
USED TO MARK THIS EDGE MUST BE WITHIN THE
SPECTRUM THAT IS SENSITIVE TO NOCTURNAL
CREATURES (TYPICALLY AMBER).

6 CATWALK LIGHTING


ALTHOUGH CONSIDERED "TEMPORARY", THE
CATWALK WILL BE ILLUMINATED IN SIMILAR
FASHION TO ALL PHASE I PATHWAYS. THE ACTUAL
PATH ALONG THE CATWALK WILL BE CONSIDERED
A "QUIET LIGHTING" ZONE AND HAVE LOW LEVEL
LIGHTING ILLUMINATING THE GROUND PLANE,
WITHOUT INTERRUPTING THE VIEWS OUT AND
ACROSS THE SITE AND RIVER. STRUCTURE OF THE
CATWALK WILL OFFER A CONDUIT FOR SITE POWER
TO RUN, AS WELL AS STRUCTURE FOR HIGHER
LEVELS OF LIGHTING NEEDED FOR GENERAL
LIGHTING OF THE YARD.

7 PLATFORM LIGHTING

THE RECOVERY BOILER BASE, BEING A TEMPORARY
ELEMENT OF PHASE 1, SHOULD BE LIT TO FEATURE
THE EXISTING EQUIPMENT WITHIN. SAFETY
LIGHTING IS ALSO A PRIORITY. SEE L-306

SYMBOL LEGEND

- PROPERTY LINE
- PHASE 1 BOUNDARY
- INTERIM ACCESS AREA
- 1996 FLOOD LINE
- OHWE (ORDINARY HIGH WATER ELEV.)
- OLWE (ORDINARY LOW WATER ELEV.)*
- *MAY OVERLAP WITH PROPERTY LINE

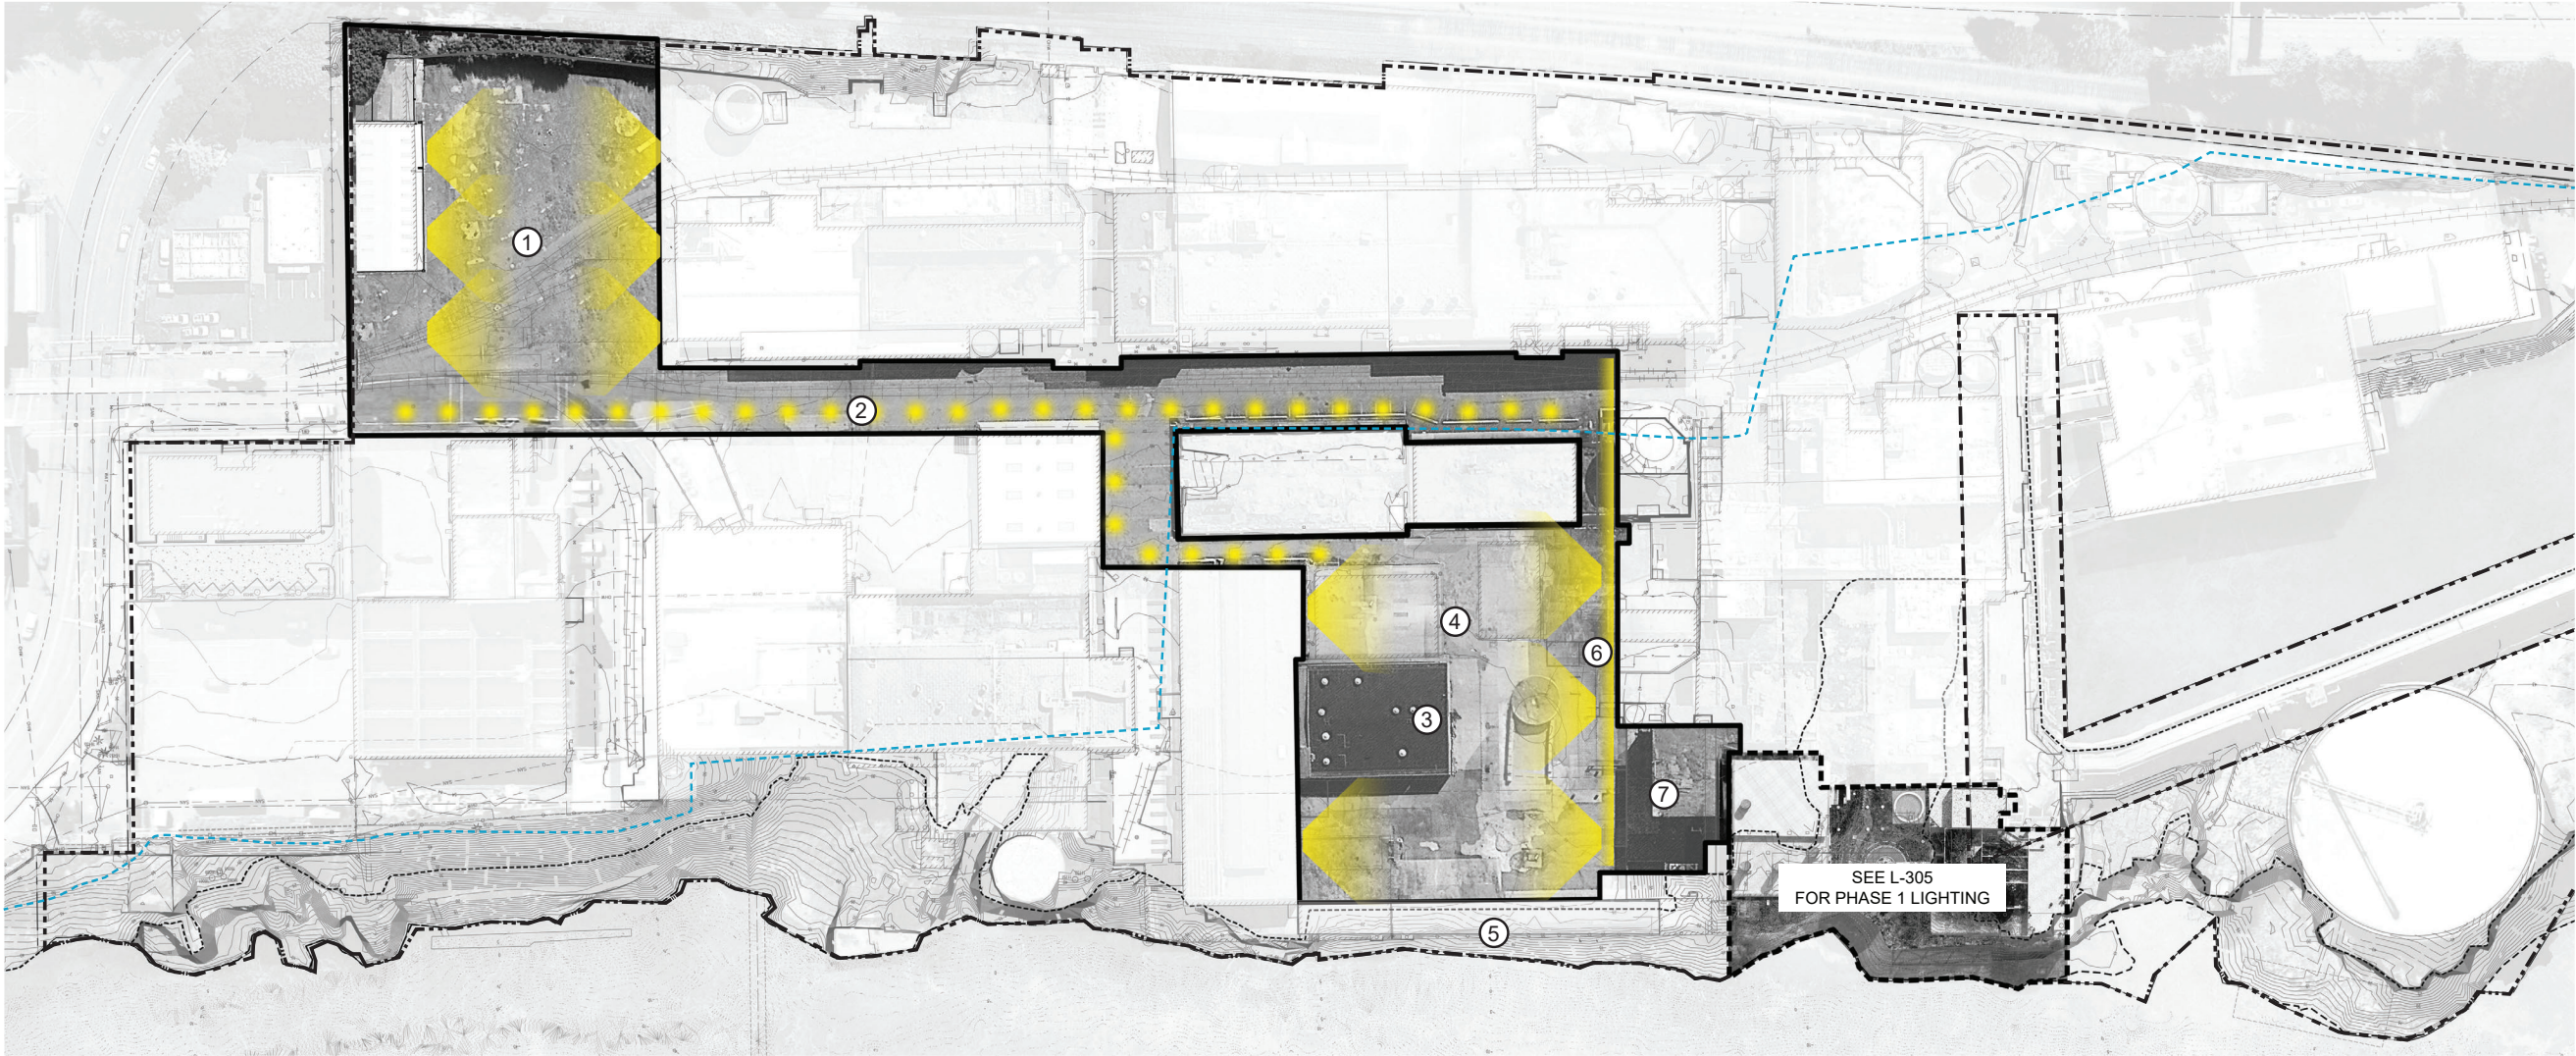

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OREGON CITY LIGHTING REQUIREMENTS:

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- OUTDOOR LIGHTING, IF PROVIDED, SHALL BE PROVIDED IN A MANNER THAT ENHANCES SECURITY, IS APPROPRIATE

FOR THE USE, AVOIDS ADVERSE IMPACTS ON SURROUNDING PROPERTIES, AND THE NIGHT SKY THROUGH APPROPRIATE SHIELDING AS DEFINED IN THIS SECTION. GLARE SHALL NOT CAUSE ILLUMINATION ON OTHER PROPERTIES IN EXCESS OF A MEASUREMENT OF 0.5 FOOT-CANDLES OF LIGHT AS MEASURED AT THE PROPERTY LINE. IN NO CASE SHALL EXTERIOR LIGHTING ADD MORE THAN 0.5 FOOT-CANDLE TO ILLUMINATION LEVELS AT ANY POINT OFF-SITE. EXTERIOR LIGHTING IS NOT REQUIRED EXCEPT FOR PURPOSES OF PUBLIC SAFETY. HOWEVER, IF INSTALLED, ALL EXTERIOR LIGHTING SHALL MEET THE FOLLOWING DESIGN STANDARDS:

- ANY LIGHT SOURCE OR LAMP THAT EMITS MORE THAN NINE HUNDRED LUMENS (THIRTEEN WATT COMPACT FLUORESCENT OR SIXTY WATT INCANDESCENT) SHALL BE CONCEALED OR SHIELDED WITH A FULL CUT-OFF STYLE FIXTURE IN ORDER TO MINIMIZE THE POTENTIAL FOR GLARE AND UNNECESSARY DIFFUSION ON ADJACENT PROPERTY. ALL FIXTURES SHALL UTILIZE ONE OF THE FOLLOWING BULB TYPES: METAL HALIDE, INDUCTION LAMP, COMPACT FLUORESCENT, INCANDESCENT (INCLUDING TUNGSTEN-HALOGEN), OR HIGH PRESSURE SODIUM WITH A COLOR RENDERING INDEX ABOVE SEVENTY.

- THE MAXIMUM HEIGHT OF ANY LIGHTING POLE SERVING A MULTI-FAMILY RESIDENTIAL USE SHALL BE TWENTY FEET. THE MAXIMUM HEIGHT SERVING ANY OTHER TYPE OF USE SHALL BE TWENTY-FIVE FEET, EXCEPT IN PARKING LOTS LARGER THAN FIVE ACRES, THE MAXIMUM HEIGHT SHALL BE THIRTY-FIVE FEET IF THE POLE IS LOCATED AT LEAST ONE HUNDRED FEET FROM ANY RESIDENTIAL USE.

- REFER TO TABLE 1-17.62.065 FOR REQUIRED FOOT-CANDLE LEVELS

- PARKING LOTS AND OTHER BACKGROUND SPACES SHALL BE ILLUMINATED AS UNOBTUSIVELY AS POSSIBLE WHILE MEETING THE FUNCTIONAL NEEDS OF SAFE CIRCULATION AND PROTECTION OF PEOPLE AND PROPERTY. FOREGROUND SPACES, SUCH AS BUILDING ENTRANCES AND OUTSIDE SEATING AREAS, SHALL UTILIZE PEDESTRIAN SCALE LIGHTING THAT DEFINES THE SPACE WITHOUT GLARE.

- ANY ON-SITE PEDESTRIAN CIRCULATION SYSTEM SHALL BE LIGHTED TO ENHANCE PEDESTRIAN SAFETY AND ALLOW EMPLOYEES, RESIDENTS, CUSTOMERS OR THE PUBLIC TO USE THE WALKWAYS AT NIGHT. PEDESTRIAN WALKWAY LIGHTING THROUGH PARKING LOTS SHALL BE LIGHTED TO LIGHT THE WALKWAY AND ENHANCE PEDESTRIAN SAFETY PURSUANT TO TABLE 1.

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- LIGHTING ON AUTOMOBILE SERVICE STATION, CONVENIENCE STORE, AND OTHER OUTDOOR CANOPIES SHALL BE FULLY RECESSED INTO THE CANOPY AND SHALL NOT PROTRUDE DOWNWARD BEYOND THE CEILING OF THE CANOPY.

- THE STYLE OF LIGHT STANDARDS AND FIXTURES SHALL BE CONSISTENT WITH THE STYLE AND CHARACTER OF ARCHITECTURE PROPOSED ON THE SITE.

- IN NO CASE SHALL EXTERIOR LIGHTING ADD MORE THAN ONE FOOT-CANDLE TO ILLUMINATION LEVELS AT ANY POINT OFF-SITE. - ALL OUTDOOR LIGHT NOT NECESSARY FOR SECURITY PURPOSES SHALL BE REDUCED, ACTIVATED BY MOTION SENSOR DETECTORS, OR TURNED OFF DURING NON-OPERATING HOURS.

- LIGHT FIXTURES USED TO ILLUMINATE FLAGS, STATUES, OR ANY OTHER OBJECTS MOUNTED ON A POLE, PEDESTAL, OR PLATFORM SHALL USE A NARROW CONE BEAM OF LIGHT THAT WILL NOT EXTEND BEYOND THE ILLUMINATED OBJECT.

- FOR UPWARD-DIRECTED ARCHITECTURAL, LANDSCAPE, AND DECORATIVE LIGHTING, DIRECT LIGHT EMISSIONS SHALL NOT BE

VISIBLE ABOVE THE BUILDING ROOFLINE. - NO FLICKERING OR FLASHING LIGHTS SHALL BE PERMITTED, EXCEPT FOR TEMPORARY DECORATIVE SEASONAL LIGHTING.

- WIRELESS SITES. UNLESS REQUIRED BY THE FEDERAL AVIATION ADMINISTRATION OR THE OREGON AERONAUTICS DIVISION, ARTIFICIAL LIGHTING OF WIRELESS COMMUNICATION TOWERS AND ANTENNAS SHALL BE PROHIBITED. STROBE LIGHTING OF WIRELESS COMMUNICATION FACILITIES IS PROHIBITED UNLESS REQUIRED BY THE FEDERAL AVIATION ADMINISTRATION. SECURITY LIGHTING FOR EQUIPMENT SHELTERS OR CABINETS AND OTHER ON-THE-GROUND AUXILIARY EQUIPMENT ON WIRELESS COMMUNICATION FACILITIES SHALL BE INITIATED BY MOTION DETECTING LIGHTING.

- LIGHTING FOR OUTDOOR RECREATIONAL USES SUCH AS BALL FIELDS, PLAYING FIELDS, TENNIS COURTS, AND SIMILAR USES, PROVIDED THAT SUCH USES COMPLY WITH THE FOLLOWING STANDARDS: I. MAXIMUM PERMITTED LIGHT POST HEIGHT: EIGHTY FEET. II. MAXIMUM PERMITTED ILLUMINATION AT THE PROPERTY LINE: 0.5 FOOT-CANDLES

1

PHASE 1 INTERIM CONDITION LIGHTING DIAGRAM

SCALE: 1" = 60'-0"



ISSUED FOR

1 PHASE I DRAWING SET 6/29/2018

NOT FOR CONSTRUCTION

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CLIENT:



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CLIENT CONSULTANTS:

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---	--

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SEAL

Willamette Falls
RIVERWALK PROJECT


PHASE 1 INTERIM
LIGHTING PLAN

DRAWN: EG
PLOT DATE: 6/29/2018

CHECKED: MM

L- 304

DRAWING NO:

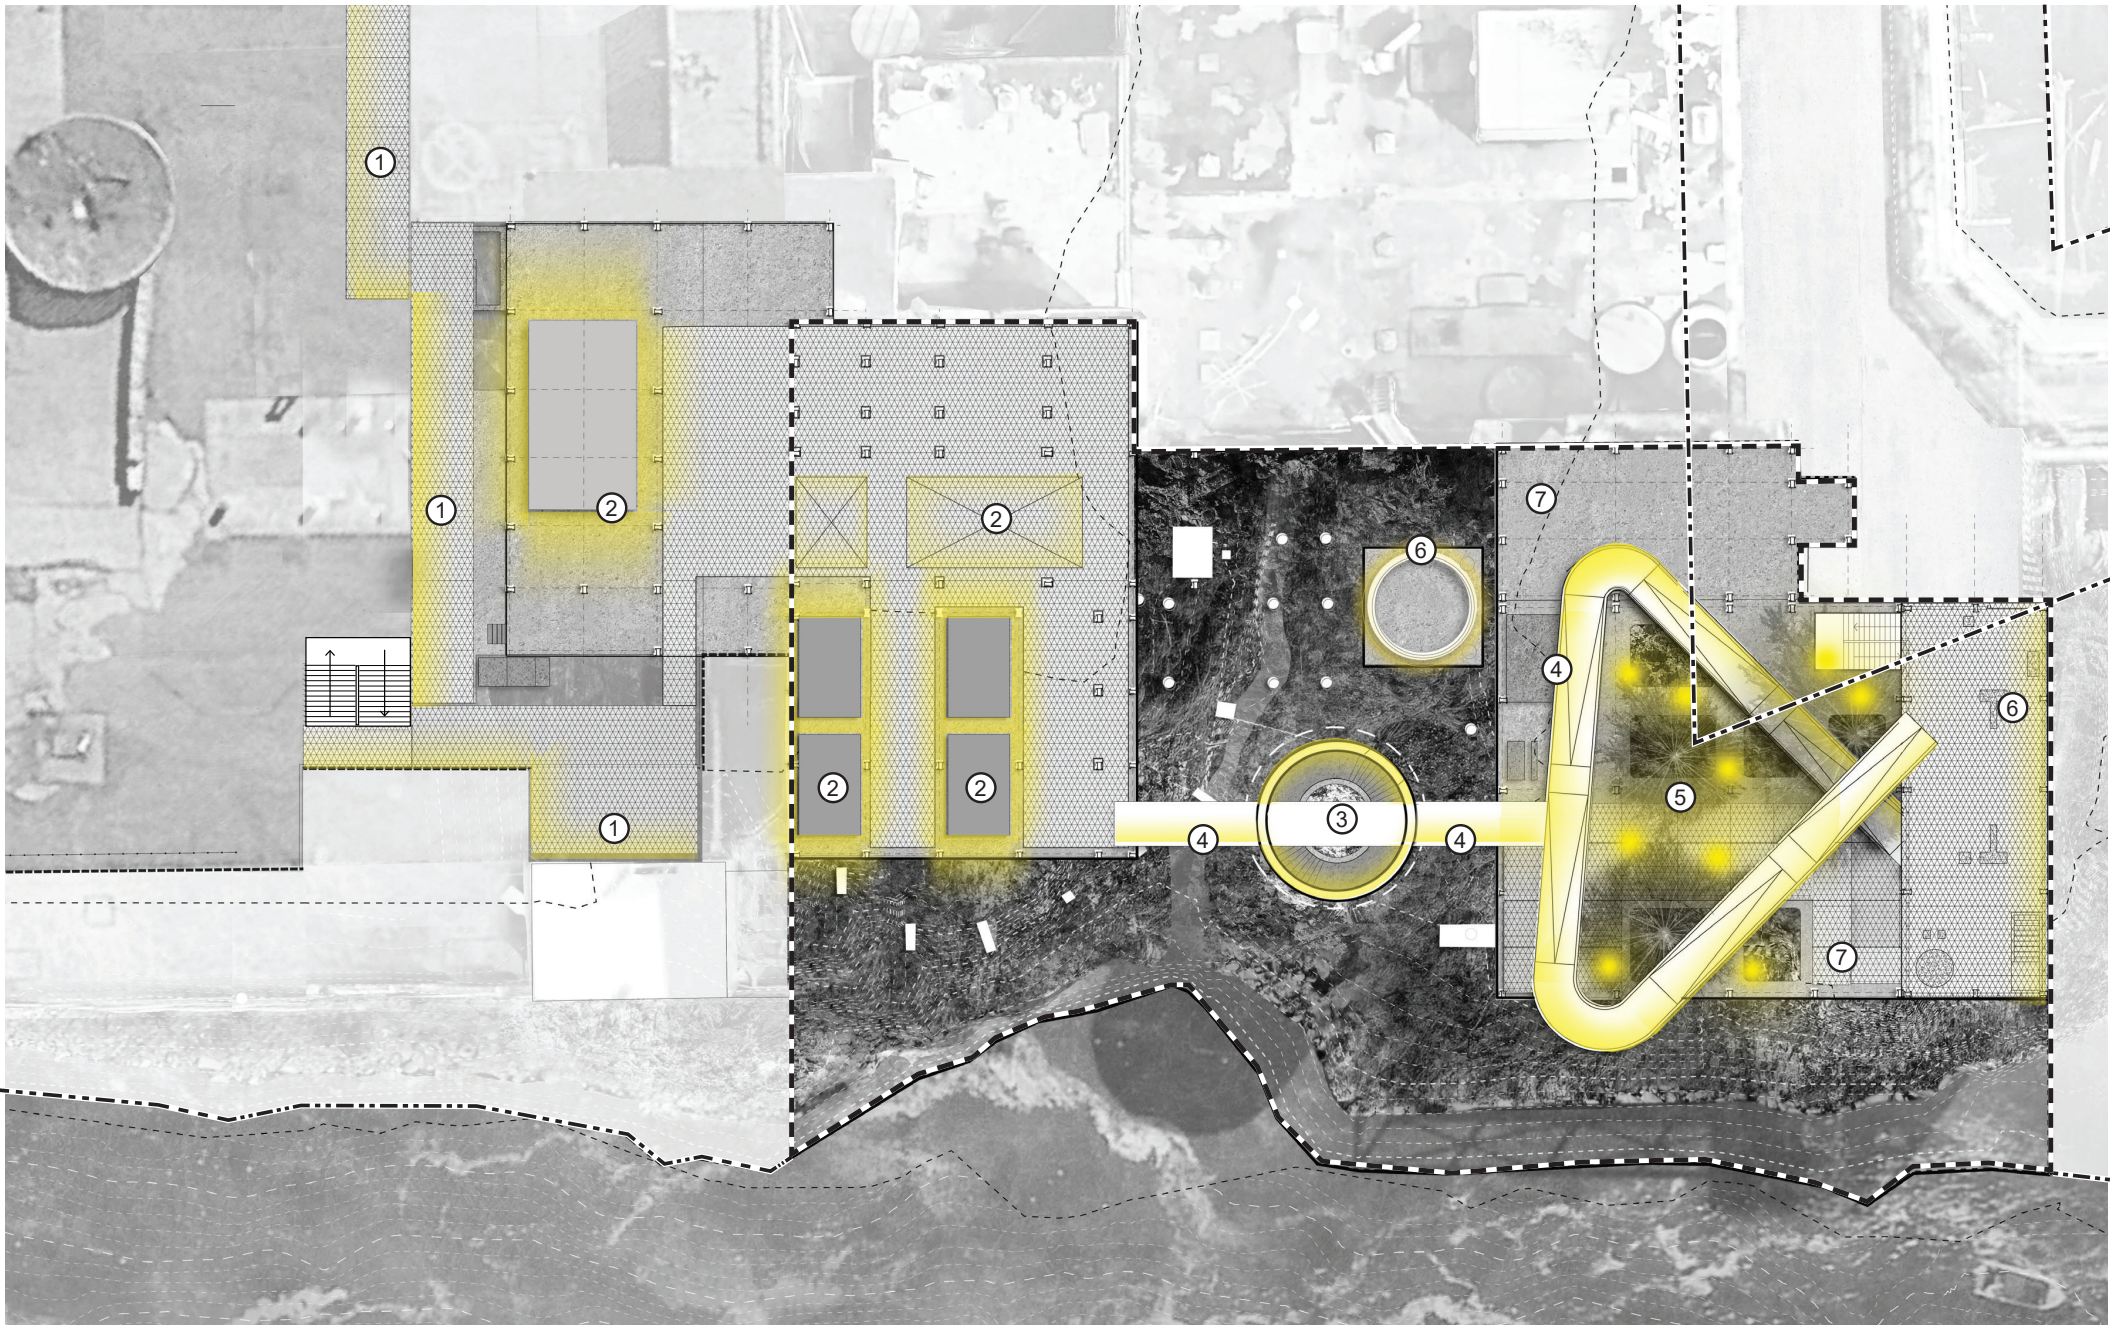

SYMBOL LEGEND

- PROPERTY LINE
- PHASE 1 BOUNDARY
- INTERIM ACCESS AREA
- OHWE (ORDINARY HIGH WATER ELEV.)
- OLWE (ORDINARY LOW WATER ELEV.)*
- *MAY OVERLAP WITH PROPERTY LINE

LIGHTING NOTES

- ① TEMPORARY CATWALK AND STAIR LIGHTING
- SEE #6 L - 304
- ② BOILER AND RECOVERY BOILER LIGHTING
A LARGE OPEN SPACE THAT OPENS UP TO ASSERTIVE LIGHTING, WHETHER AN ART EXHIBITION, INSTALLATION, OR FREEDOM TO SIMPLY WANDER THROUGH THE VAST SPACE AND MARVEL AT THE REMNANTS OF AN ERA GONE BY.
- ③ STOCK CYLINDER LIGHTING
THE NEXT OF THE JOURNEY IS COMPRESSED AND VERTICAL, WHERE THE BOILER ROOM WAS VAST AND WIDE. A QUIETLY LIT PATHWAY BRIDGE TAKES YOU THROUGH THE CENTER WHERE ABOVE AND BELOW VOIDS ARE ILLUMINATED.
OPTION: IMAGE PROJECTION ON CYLINDER WALLS.
- ④ PATHWAY LIGHTING
QUIET CIRCULATION PATHWAYS ALLOW VISITORS TO BE ABSORBED BY THE SURROUNDINGS. LOW LEVEL LIGHTING GUIDES VISITORS INTO, THROUGH, AND OUT OF VARIOUS STRUCTURAL ELEMENTS. THE UNIFIED LIGHTING HELPS PROMOTE SUBLIMINAL WAYFINDING
- ⑤ GROVE LIGHTING
USING LIGHTING FROM ABOVE AND/OR BELOW TO CREATE A FOCAL POINT FOR THE EYE TO REST UPON.
- ⑥ HABITAT EDGE
CRITICAL POINT WHERE LIGHTING MUST BE MINIMALIZED TO ONLY WHAT IS NECESSARY FOR SAFETY AND SECURITY. VITAL TO BOTH VIEWS AND INTERACTION WITH NOCTURNAL SPECIES IN SURROUNDING HABITAT.
- ⑦ MILL H
A QUIET PERIMETER ALLOWS CIRCULATION AND CONTEMPLATION LOOKING WITH AND WITHOUT. AN ASSERTIVE CENTRAL ZONE CREATES FOCUS ON THE TREE GROVE AND RAMP TO UPPER LEVELS.

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- THE MAXIMUM HEIGHT OF ANY LIGHTING POLE SERVING A MULTI-FAMILY RESIDENTIAL USE SHALL BE TWENTY FEET. THE MAXIMUM HEIGHT SERVING ANY OTHER TYPE OF USE SHALL BE TWENTY-FIVE FEET, EXCEPT IN PARKING LOTS LARGER THAN FIVE ACRES, THE MAXIMUM HEIGHT SHALL BE THIRTY-FIVE FEET IF THE POLE IS LOCATED AT LEAST ONE HUNDRED FEET FROM ANY RESIDENTIAL USE.

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CANDLE AVERAGE, AND A MAXIMUM TO MINIMUM RATIO OF SEVENTO-ONE AND SHALL BE ORIENTED NOT TO SHINE UPON ADJACENT PROPERTIES. STREET LIGHTING SHALL BE PROVIDED AT BOTH ENTRANCES. LAMPS SHALL INCLUDE A HIGH-PRESSURE SODIUM BULB WITH AN UNBREAKABLE LENS.

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- LIGHTING ON AUTOMOBILE SERVICE STATION, CONVENIENCE STORE, AND OTHER OUTDOOR CANOPIES SHALL BE FULLY RECESSED INTO THE CANOPY AND SHALL NOT PROTRUDE DOWNWARD BEYOND THE CEILING OF THE CANOPY.

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VISIBLE ABOVE THE BUILDING ROOFLINE. - NO FLICKERING OR FLASHING LIGHTS SHALL BE PERMITTED, EXCEPT FOR TEMPORARY DECORATIVE SEASONAL LIGHTING.

- WIRELESS SITES. UNLESS REQUIRED BY THE FEDERAL AVIATION ADMINISTRATION OR THE OREGON AERONAUTICS DIVISION, ARTIFICIAL LIGHTING OF WIRELESS COMMUNICATION TOWERS AND ANTENNAS SHALL BE PROHIBITED. STROBE LIGHTING OF WIRELESS COMMUNICATION FACILITIES IS PROHIBITED UNLESS REQUIRED BY THE FEDERAL AVIATION ADMINISTRATION. SECURITY LIGHTING FOR EQUIPMENT SHELTERS OR CABINETS AND OTHER ON-THE-GROUND AUXILIARY EQUIPMENT ON WIRELESS COMMUNICATION FACILITIES SHALL BE INITIATED BY MOTION DETECTING LIGHTING.

- LIGHTING FOR OUTDOOR RECREATIONAL USES SUCH AS BALL FIELDS, PLAYING FIELDS, TENNIS COURTS, AND SIMILAR USES, PROVIDED THAT SUCH USES COMPLY WITH THE FOLLOWING STANDARDS: I. MAXIMUM PERMITTED LIGHT POST HEIGHT: EIGHTY FEET. II. MAXIMUM PERMITTED ILLUMINATION AT THE PROPERTY LINE: 0.5 FOOT-CANDLES

1

PHASE 1 LIGHTING DIAGRAM AT DAM LEVEL

SCALE: 1/16" = 1'-0"

ISSUED FOR

1 PHASE I DRAWING SET 6/29/2018

NOT FOR CONSTRUCTION

IMPERIAL

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SEAL

Willamette Falls
RIVERWALK PROJECT

PHASE 1
LIGHTING PLAN

DRAWN: EG
PLOT DATE: 6/29/2018

CHECKED: MM

L- 305

DRAWING NO:

00' 16' 32'

